18529 W. CALVERT ST. RESEDA CA 91335

PROJECT ADDRESS 18529 W. CALVERT ST. RESEDA, CA 91335 PROJECT OWNER

DESIGN & STRUCTURE ENGINEER

G.A. ENGINEERING 19562 VENTURA Blvd. Suite 230 TARZANA, CA. 91356 Phone: (818) 758-0018

PUBLIC WORKS PLANS:

SURVEY:

5642 ETIWANDA AVENUE, UNIT NO. 9, TARZANA CA 91356 Phone: (818) 482-6532, E-mail: kklsurveying@gmail.com.

GEOTECHNICAL ENGINEER

	ARCHITECTURAL
SHEET	TITLE
A - 0	COVER SHEET
A-1	SITE PLAN
A-2	BASEMENT FLOOR
A-3	FIRST FLOOR
A-4	SECOND FLOOR
A-5	THIRD FLOOR
A-6	FOURTH FLOOR
A-7	ROOF PLAN
A-8	NORTH&WEST ELEVATIONS
A-9	SOUTH&EAST ELEVATIONS
A-10	SECTIONS
A-11	DOOR & WINDOW SCHEDULE
	LANDSCAPING
L-1	LANDSCAPE PLAN

PROJECT DATA

ADDRESS:	18529 W. CALVERT ST. RESEDA, CA 91335					
PROJECT SCOPE:	(24) UNIT APARTMENT BUILDING, 3—STORY RESIDENTIAL/GARAGE OVER BASEMENT					
LEGAL DESCRIPTION	THE WEST 144 FEET OF LOT 33 OF TRACT NO. 7691, IN THE CITY OF LOS ANGELES COUNTY OF LOS ANGELES, STATE OF CALIFORNIA, AS PER MAP RECORDED IN BOOK 89, PAGES 23 AND 24 OF MAPS, IN THE OFFICE OF THE COUNTY RECORDER OF SAID COUNTY AND AS DESCRIBED IN THE DEED RECORDED AS INSTRUMENT NO. 20140145758 OF OFFICIAL RECORDS OF SAID COUNTY.					
ASSESSOR PARCEL NO. (APN)	2127015026					
BUILDING CODE:	2013 CBC AS AMENDED BY CITY OF LOS ANGELES					
EXISTING ZONE:	RA-1-K-RIO					
PROPOSED ZONE:	(T)(Q)R3-1-K-RIO					
GENERAL PLAN LAND USE	MEDIUM RESIDENTIAL					
COMMUNITY PLAN AREA	RESEDA — WEST VAN NUYS					
AREA PLANNING COMMISSION	SOUTH VALLEY					
TYPE OF CONSTRUCTION:	BASEMENT- TYPE "IA" GARAGE, FULLY SPRINKELERED THROUGHOUT (NFPA-13) IST Thru 4TH FLOORS, TYPE V-A , FULLY SPRINKELERED THROUGHOUT (NFPA-13)					
GROSS LOT AREA:	16,561.1 SQFT					
NET LOT AREA:	13,661.1 SQFT					
PROPOSED BUILDING HEIGHT:	45 FEET					
OCCUPANCY GROUP	R-2 / S-2 PARKING					
BUILDING SETBACKS:	FRONT YARD: 15 FEET SIDE YARDS: 6 FEET REAR YARD: 15 FEET					
STORIES:	3-STORY RESIDENTIAL OVER BASEMENT GARAGE					

OPEN SPACE CALCULATION

PARKING REQUIRED PER	LAMC 12.22.25
(AFFORDABLE HOUSING),	PARKING OPTION 1

# OF UNITS	AUTO PARKING	TOTAL
10	1	10
14	2	28
0	0	0
24		38
	10 14 0	ÜNITS PARKING 10

PARKING CALCULATION

PROVIDE * (3) SHORT-TERM BICYCLE PARKING

* (24) LONG-TERM BICYCLE PARKING

PARKING PROVIDED	
	PARKING No.
STANDARD	23
COMPACT	22
DISABLE PARKING, RESIDENTS	1
TOTAL AUTO PARKING RESIDENTS	46
TOTAL LONG TERM BICYCLE PARKING TOTAL SHORT TERM BICYCLE PARKING	24 3
TOTAL PARKING	46

REQUIRED

NO. OF BEDROOMS	NO.OF HABITABLE ROOMS	QUANT.	OPEN SPACE
1	2	10	10 X 100 = 1000
2	3	14	14 X 125 = 1,750
3	4	_	$0 \times 175 = 0$
TOT	ΓAL	24	2,750 SQ.FT.

PROVIDED

AREA DESCRIPTION	OPEN SPACE
CENTER COURT YARD, FIRST FLOOR	548 SQ.FT.
BALCONIES, 18 X 50	900 SQ.FT.
REAR YARD	1,500 SQ.FT
TOTAL	2,948 SQ.FT.

AREA SUMMARY (LABC)

			A	$A \qquad \qquad B$		D	A-B-C	A-B-C-D
STORY OCC.		USE	GROSS AREA (OUT TO OUT BLDG) SQ.FT.	AREA: EXTERIOR WALLS SQ.FT.	AREA: VENT SHAFTS SQ.FT.	AREA: STAIRWAYS ELEVATOR SQ.FT.	BUILDING CODE FLOOR AREA SQ.FT.	ZONING CODE FLOOR AREA SQ.FT.
BASEMENT	S-2	PARKING	11,892				11,892	11,892
TI DOM	S-2	PARKING	6,70				670	670
FIRST	R-2	RESIDENTIAL	6,292	249	6	326	6,037	5,711
SECOND	R-2	RESIDENTIAL	8,660	219	6	464	8,441	7,977
THIRD	R-2	RESIDENTIAL	8,660	219	6	464	8,441	7,977
TOTAL	S-2		12,562				12,562	12,562
	R-2						22,919	21,665

ZONE CHANGE NOTES:

1) CURRENT GENERAL PLAN DESIGNATION: GENERAL COMMERCIAL, MEDIUM RESIDENTIAL
2) PROPOSED GENERAL PLAN DESIGNATION: NO CHANGE
3) CURRENT ZONE: RA-1-K-RIO

4) PROPOSED ZONE: (T)(Q) R3-1-K-RIO

[T](Q)R3-1

DENSITY CALCULATION:


(T)(Q) R3-1 : 16,561.1 / 800 = 20.7 = 20

DENSITY BONUS:
UNIT ALLOCATED TO VERY LOW INCOME= 5% X20 =1
BONUS UNITS = 20% X20=4
TOTAL UNITS=20+4 = 24 UNITS

FLOOR AREA CALCULATION:

R3 PORTION: 3:1 FAR

3X 115'X114'= 39,330 SQ.FT.

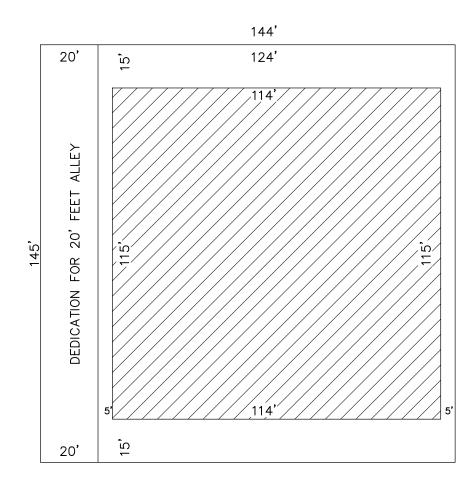

SCHOOL DISTRICT ASSESSABLE

STORY	USE	AREA (SQ.FT.)
FIRST	DWELLING UNITS	6,292
SECOND	DWELLING UNITS	8,660
THIRD	DWELLING UNITS	8,660
TOTAL		23,612

ATTACHMENT A

ATTACHMENT A

Job Address ____

CITY OF LOS AND

Storm Water Pollution Control Requirements for Construction Activities Minimum Water Quality Protection requirements for All construction Projects/Certification Statement

The following notes shall be either incorporated or attached to the approved construction/grading plans and represents the minimum standards of good house keeping which must be implemented on all construction projects.

Construction means constructing, clearing, grading or excavation that result in soil disturbance.

Construction includes structure teardown. It does not include routine maintenance to maintain original line and grade, hydraulic capacity, or original purpose of facility: emergency construction activities required to immediately protect public health and safety: interior remodeling with no outside exposure of construction material or construction waste to storm water: mechanical permit work: or original sign work. -NPEDS Permit Part 5 "Definitions"

- Eroded sediments and pollutants must be retained on site and may not be transported from the site via sheet flow, swales, area drains, natural drainage course or wind.
- Stockpiles of earth and other construction-related materials must be protected from being transported from the site by wind or water.
- Fuels, oils, solvents and other toxic materials must be stored in accordance with their listing and are not to contaminate the soil or the surface waters. All approved toxic storage containers are to be protected from the weather. Spills must be cleaned up immediately and disposed o in a proper manner. Spills may not be
- Non-storm water runoff from equipment and vehicle washing and any other activity shall be contained at the
- Excess or waste concrete may not be washed into public way or any drainage system. Provisions shall be
- made to retain concrete wastes on-site until they can be appropriately disposed of or recycled.
- Trash and construction-related solid wastes must be deposited into a covered receptacle to prevent contamination of rainwater and dispersal by wind.
- Sediments and other materials may not be tracked from the site by vehicle traffic. The construction entrance
 roadways must be stabilized so as to inhibit sediments from being deposited into public ways. Accidental
 depositions must be swept up immediately and may not be washed down by rain or by other means.

As the project owner or authorized agent of the owner, I have read and understand the requirements, listed above, necessary to control storm water pollution from sediments, erosion, and construction materials, nd I certify that I will comply with these requirements.

(Owner or authorized agent of the owner)

(Owner or authorized agent of the owner)

DEVELOPMENT BEST MANAGEMENT PRACTICES HANDBOOK

ATTN. OWNERS/CONTRACTORS:


It is the responsibility of the contractor to examine all plans and specificationsprior to starting the construction work. Contractor shall verify all discrepancies and omissions. contractor may contactarchitect/engineer for any questions details, specifications and clarifications.the architect/engineer shall not be responsible for any shortcoming on the part of the contractor or any errorcaused by the contractor as a result of ack of planning and/or foresight.each contractor shall visit the site and verify all dimensions, grades and con-ditions at the site before commencing work and report all discrepancies and modified field conditions to the arch—itect/engineer in writing.Contractor may provide only prelimin—ary bids based on this plan, if this is notapproved and stamped by the city. Final bids shall be based on approved plans only. if no general contractors retained for the job, knowledgeable project manager, job supervisor to act as his agent and assume all responsibilities.

NOTE

OBTAIN SEPARATE APPLICATION FOR THE FOLLOWING ITEMS:

RETAINING WALLS, GRADING WORK, BLOCK FENCE, FIRE SPRINKLER SYSTEM, ELECTRICAL, MECHANICAL, PLUMBING WORK, SHORING AND DEMOLITION.

VICINITY MAP

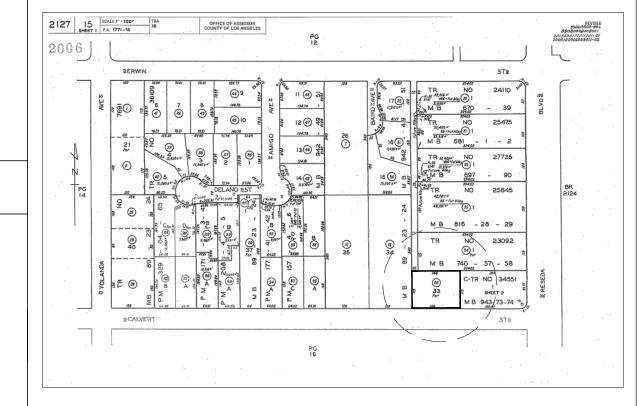

DATE: JUN 2014

SCALE: 1/8"=1'-0"

DRAWN:

APPROVED: VA.

REVISION

MARK GOLESTANI 6 PLAAT AVE # 904 1 HILL CA 91309

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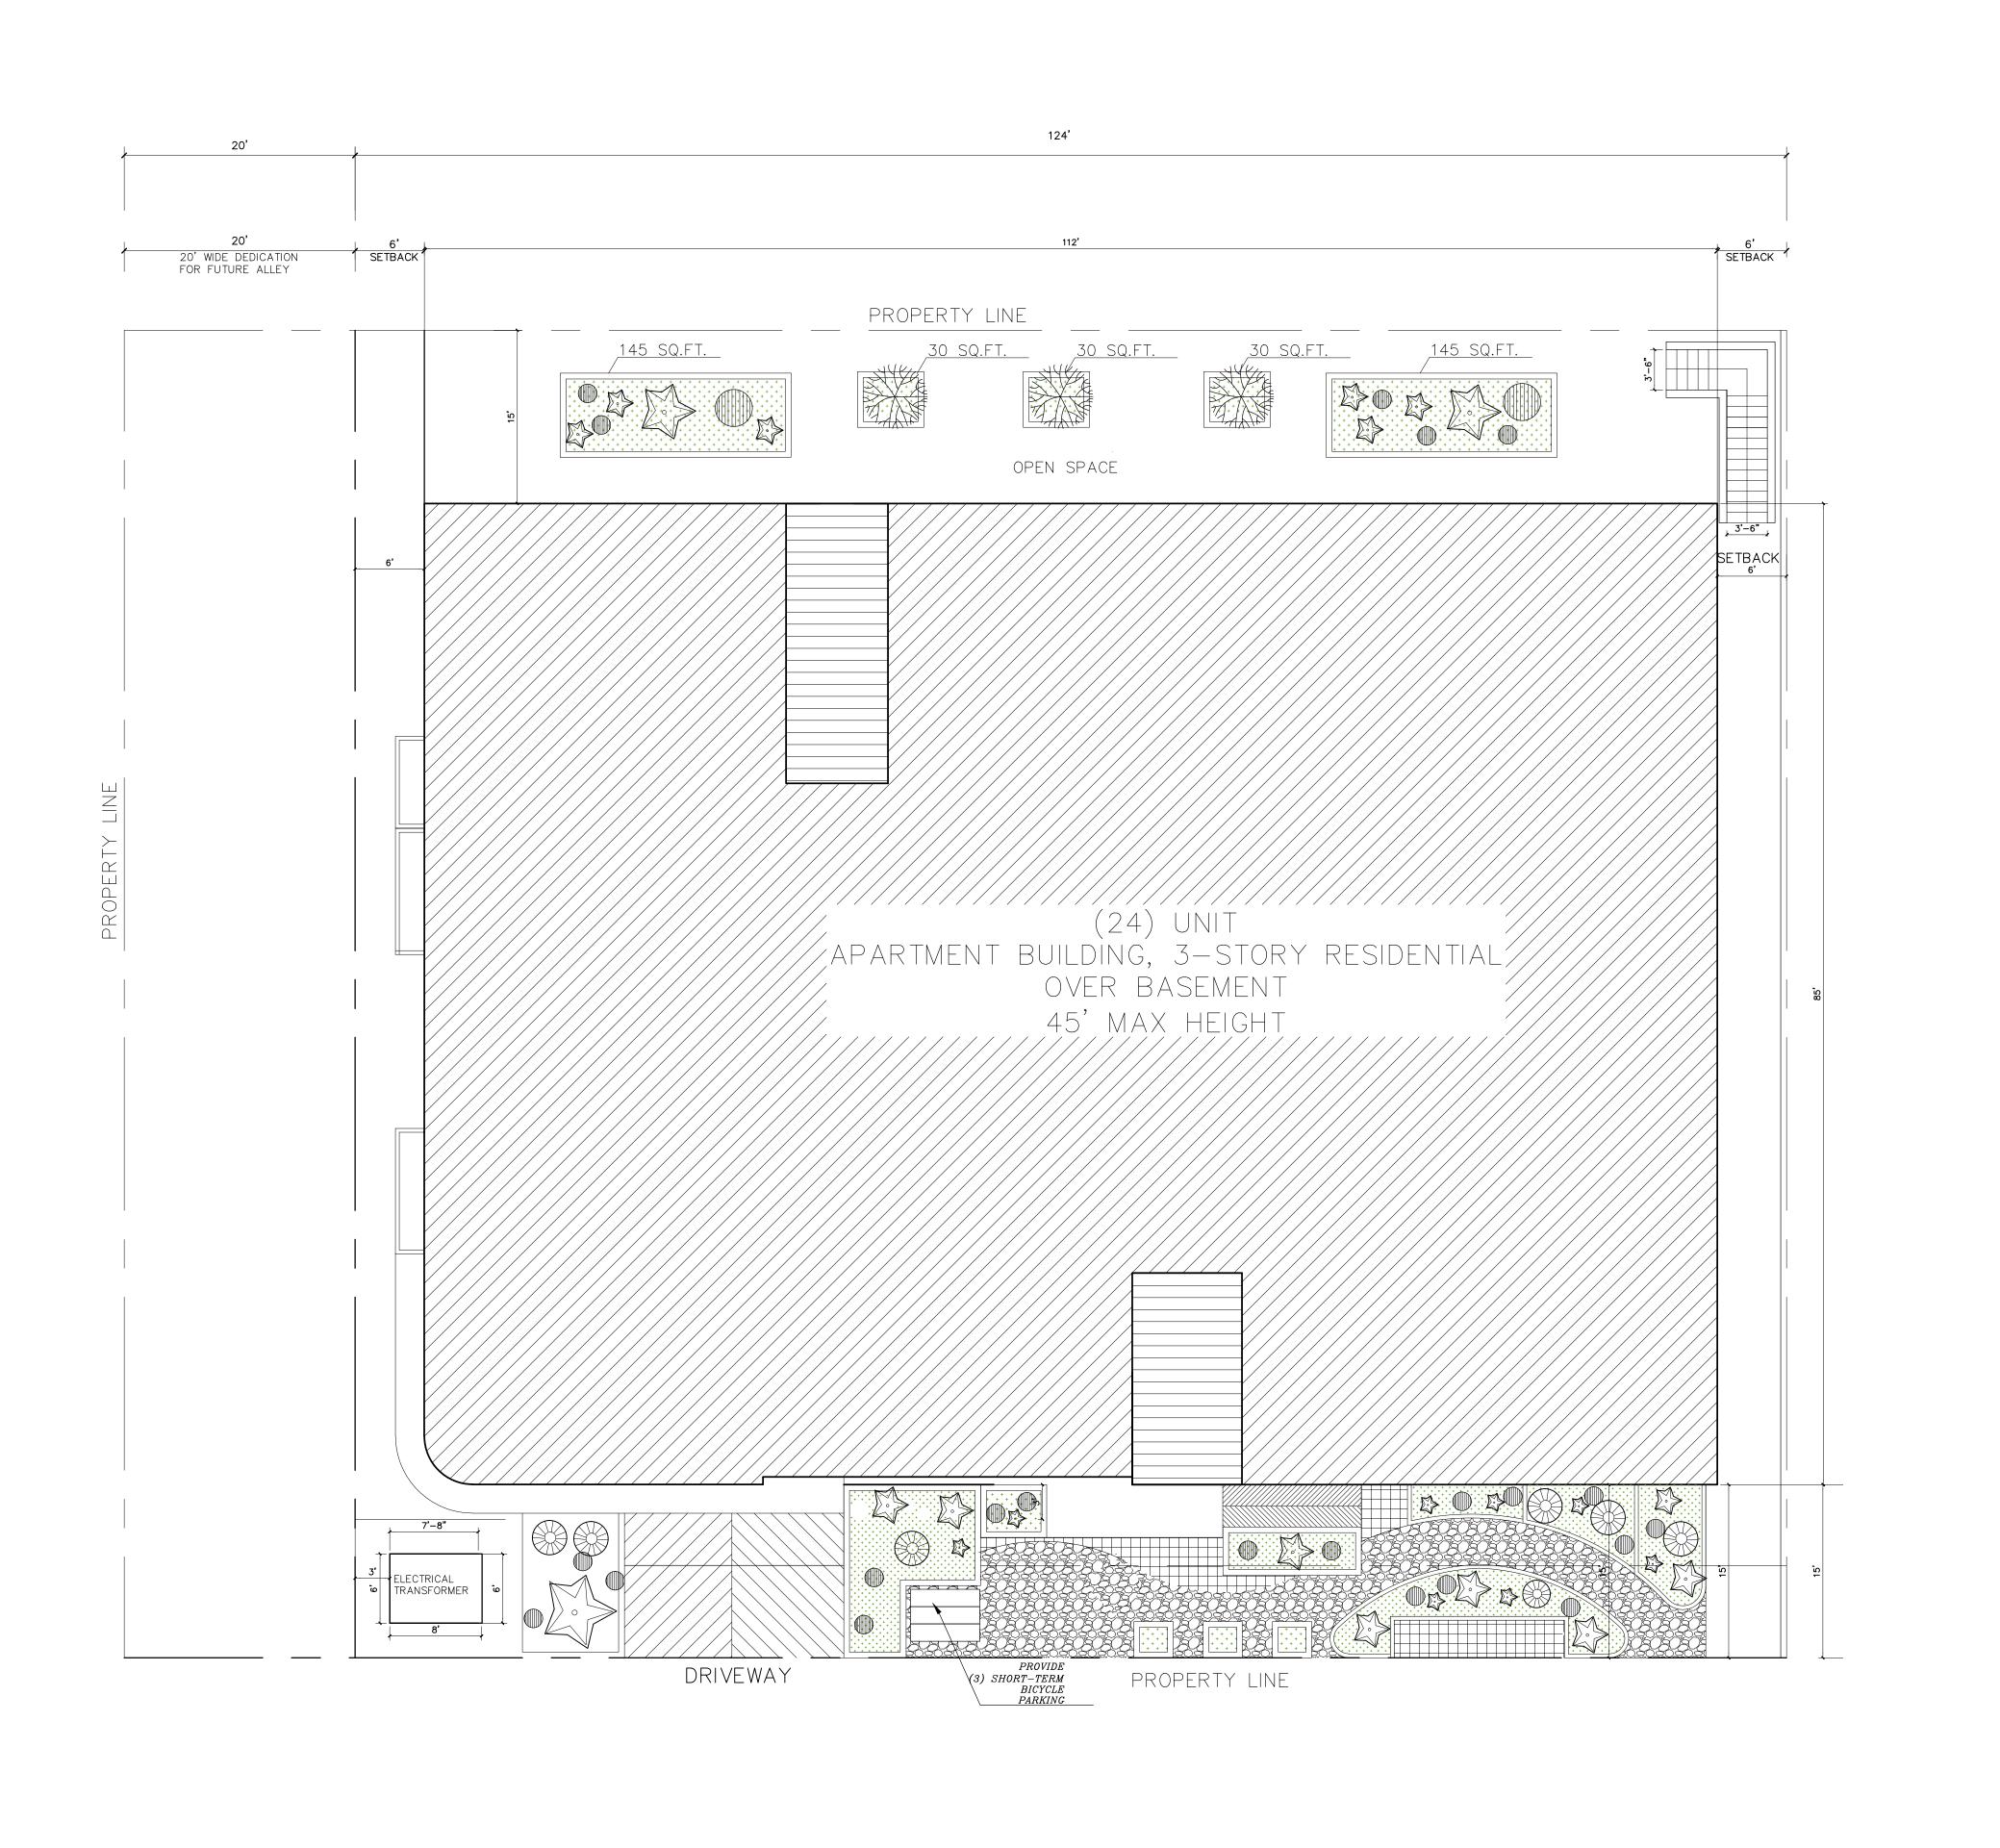
CALVERT, CA 9133

8529 RESI

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A — O



L E G E N D

1 BUILDING ENTRANCE

2 3-STORIES BUILDING WITH PARKING GARAGE

3 WALKWAY

(4) NEW DRIVEWAY

5 LANDSCAPING

6 PLANTER

7 FOR IRRIGATION CONTROLLER (4.304.1) REFER TO N-1 GB SHEET

8 BALCONY

NOTE:

1—The construction shall not restrict a five—foot clear and unobstructed access to any water or power distribution facilities (powder poles, pull boxes, transformers, vaults, pumps, valves, meters, appurtenances, etc.) or to the location of the hook—up. The construction shall not be within ten feet of any power lines—whether or not the lines are located on the property. Failure to comply may cause construction delays and/or additional expenses.

2— "DOUBLE STRIPPING OF STALLS SHALL BE PER ZONING CODE SECTION 12.21A5, CHART No. 5"

3- FOR PROJECTS THAT INCLUDE LANDSCAPE WORK THE LANDSCAPE CERTIFICATION FROM GRN-12 SHALL BE COMPLETED PRIOR TO FINAL INSPECTION APPROVAL. SEE GRADING PLANS FOR DRAINAGE

4- FOR KNOX BOX NOTES REFER TO N- SHEETS

G A FNGINFFRING	19562 VENTURA BLVD.SUITE 230 TARZANA , CALIFORNIA 91356 Phone : (818) 758-0018 Cell : (818) 203-3336	fax : (818) 708-2847
REVIS	SION BY	
OWNER	MARK GOLESTANI 6520 PLAAT AVE # 904 WEST HILL CA 91309	
PROJECT	18529 W. CALVERT RESEDA,	
	SITE PLAN	

MARCH 2015
E: 1/8"=1'-0"

DRAWN: SA.

APPROVED: VA.

A — 1

							R	SC	H E D U L E		
MARK	DOOR FIRST FLOOR		DATA	I		FRA	M E	DESCRIPTION	REMARKS	FIRE RATED	D O O R NOTE
'''' -	YPE CORE WIDTH	HEIGHT	THICK	MAT.	FIN.	MAT.	FIN.	<i>B E G G ((1) </i>			
1)	3'-0"	6'-8"		WOOD	PAINT	WOOD	PAINT	APARTMENT, ENTRY DOOR	/ SELF CLOSING	20 MIN.	EXIT DOORS SHALL BE OPENABLE FROM THE INSIDE WITHOUT THE USE OF A KEY, SPECIAL KNOWLEDGE
(2)	2'-10"	6'-8"		WOOD	PAINT	WOOD	PAINT	INTERIOR DOOR			OR EFFORT. FLUSH BOLTS OR SURFACE BOLTS ARE PROHIBITED.
(3)	3'-0"	6'-8"		WOOD	PAINT		PAINT	STAIRS, INTERIOR DOOR	/ SELF CLOSING	60 MIN.	
4	4'-0"	6'-8"		WOOD	PAINT	WOOD	PAINT	SLIDING CLOSET DOOR			EXIT DOORS SHALL BE OPENABLE FROM THE INSIDE WITHOUT THE USE OF A KEY, SPECIAL KNOWLEDGE
(5)	5'-0"	6'-8"		WOOD	PAINT	WOOD		SLIDING CLOSET DOOR			EVERY DOOR IN A SECURITY OPENING FOR AN APARTMENET HOUSE SHALL BE PROVIDED WITH A LIGHT
6	6'-0"	6'-8"		WOOD	PAINT	WOOD		SLIDING CLOSET DOOR			BULB (60 WATT MIN.) AT A MAXIMUM HEIGHT OF 8 FEET ON THE EXTERIOR.
	6'-0"	6'-8"		WOOD	PAINT	VINYL	PAINT	SLIDING			EXIT WAY DOOR WIDTH SHALL NOT BE LESS THAN 32 INCHES AND SHALL BE CAPABLE OF OPENING 90°.
(8) (9)	2'-0"	6'-8"		WOOD	PAINT	WOOD	PAINT		SELF CLOSING SMOKE GASKETED FIRE ASSEMBLY	60 MIN.	ALL REQUIRED EXIT DOORS SHALL BE NOT LESS THAN 3 FT. WIDE 6'-8 HIGH, SHALL
(9)	3'-0"	6'-8"		WOOD	PAINT	WOOD	PAINT		SMOKE GASKETED S RATED SELF.CLOSING	90 MIN.	HAVE A CLEAR EXIT WAY WIDTH OF NOT LESS THAN 32" AND SHALL BE CAPABLE OF
10	3'-0"	6'-8"		METAL	PAINT	METAL	PAINT	ELEVATOR DOOR	AUTOMATIC CLOSING ON SMOKE DET. & MAGNETIC door holders	90 MIN.	OPENING 90 DEGREES. THE MAXIMUM DOOR LEAF WIDTH IS 4 FEET WHEN SERVING AN OCCUPANT LOAD OF 10 OR MORE. (1003.3.1 .3a) & (1003.3.1.4)
(11)	6'-0"	6'-8"		WOOD	PAINT	WOOD	PAINT	DOUBLE DOOR			OCCUPANT LOAD OF 10 OK PARE. (1003.3.1 .3a) & (1003.3.1.4)
12	19'-0"	10'-0"		METAL	PAINT	METAL	PAINT	GARAGE DOUBLE DOOR	GARAGE DOUBLE DOOR		
				1							


	SLIDING		OW SCHEDULE
MARK TYPE WIDTH HEIGHT GLASS FRAME	WALL OPENING DESCRIPTION	REMARKS	WINDOW TYPES
A) 6'-0" 5'-0" VINYL B) 5'-0" 4'-0" VINYL C) 3'-0" 3'-0" VINYL D) 3'-0" 2'-0" VINYL E) 8'-0" 5'-0" VINYL F) 12'-0" 4'-0" VINYL G) 8'-0" 4'-0" VINYL H) 4'-0" 4'-0"	SINGLE HUNG SLIDING FIXED FIXED SLIDING	DUAL GLAZED DUAL GLAZED DUAL GLAZED DUAL GLAZED DUAL GLAZED	ALL GLAZING WITHIN 40" OF ENTRY DOOR HANDLE SHALL BE TEMPERED.
REFERE	N C E N O	T E S	REFERENCE NOTES
NOTE: WHERE MORE THAN ONE MATERIAL OR FINISH IS LI	ISTED REFER TO FLOOR PLAN AND/OR INTERIOR	R ELEVATIONS FOR CLARIFICATION.	
2 CARPET AND PAD14 C3 EXPOSED CONC. SLAB15 C4 SHEET VINYL16 G5 VINYL BASE17 C6 ENAMEL PAINT18 C7 FLAT LATEX PAINT19 FL	CONC. WALL W/GYP. BD. O/BATT. INSULCONC. BLOCK WALL GLASS WALL CEMENT PLASTER W/INTG. COLOR	 WOOD BASE EALSTOMERIC TOPPING HARDWOOD FLOORING 28 29 30 31 32 	

OWNER

MARK GOLESTANI 6520

PLAAT AVE # 904 WEST

HILL CA 91309 18529 W. CALVERT ST. RESEDA, CA 91335 PROJECT SCALE: 1/8"=1'-0"

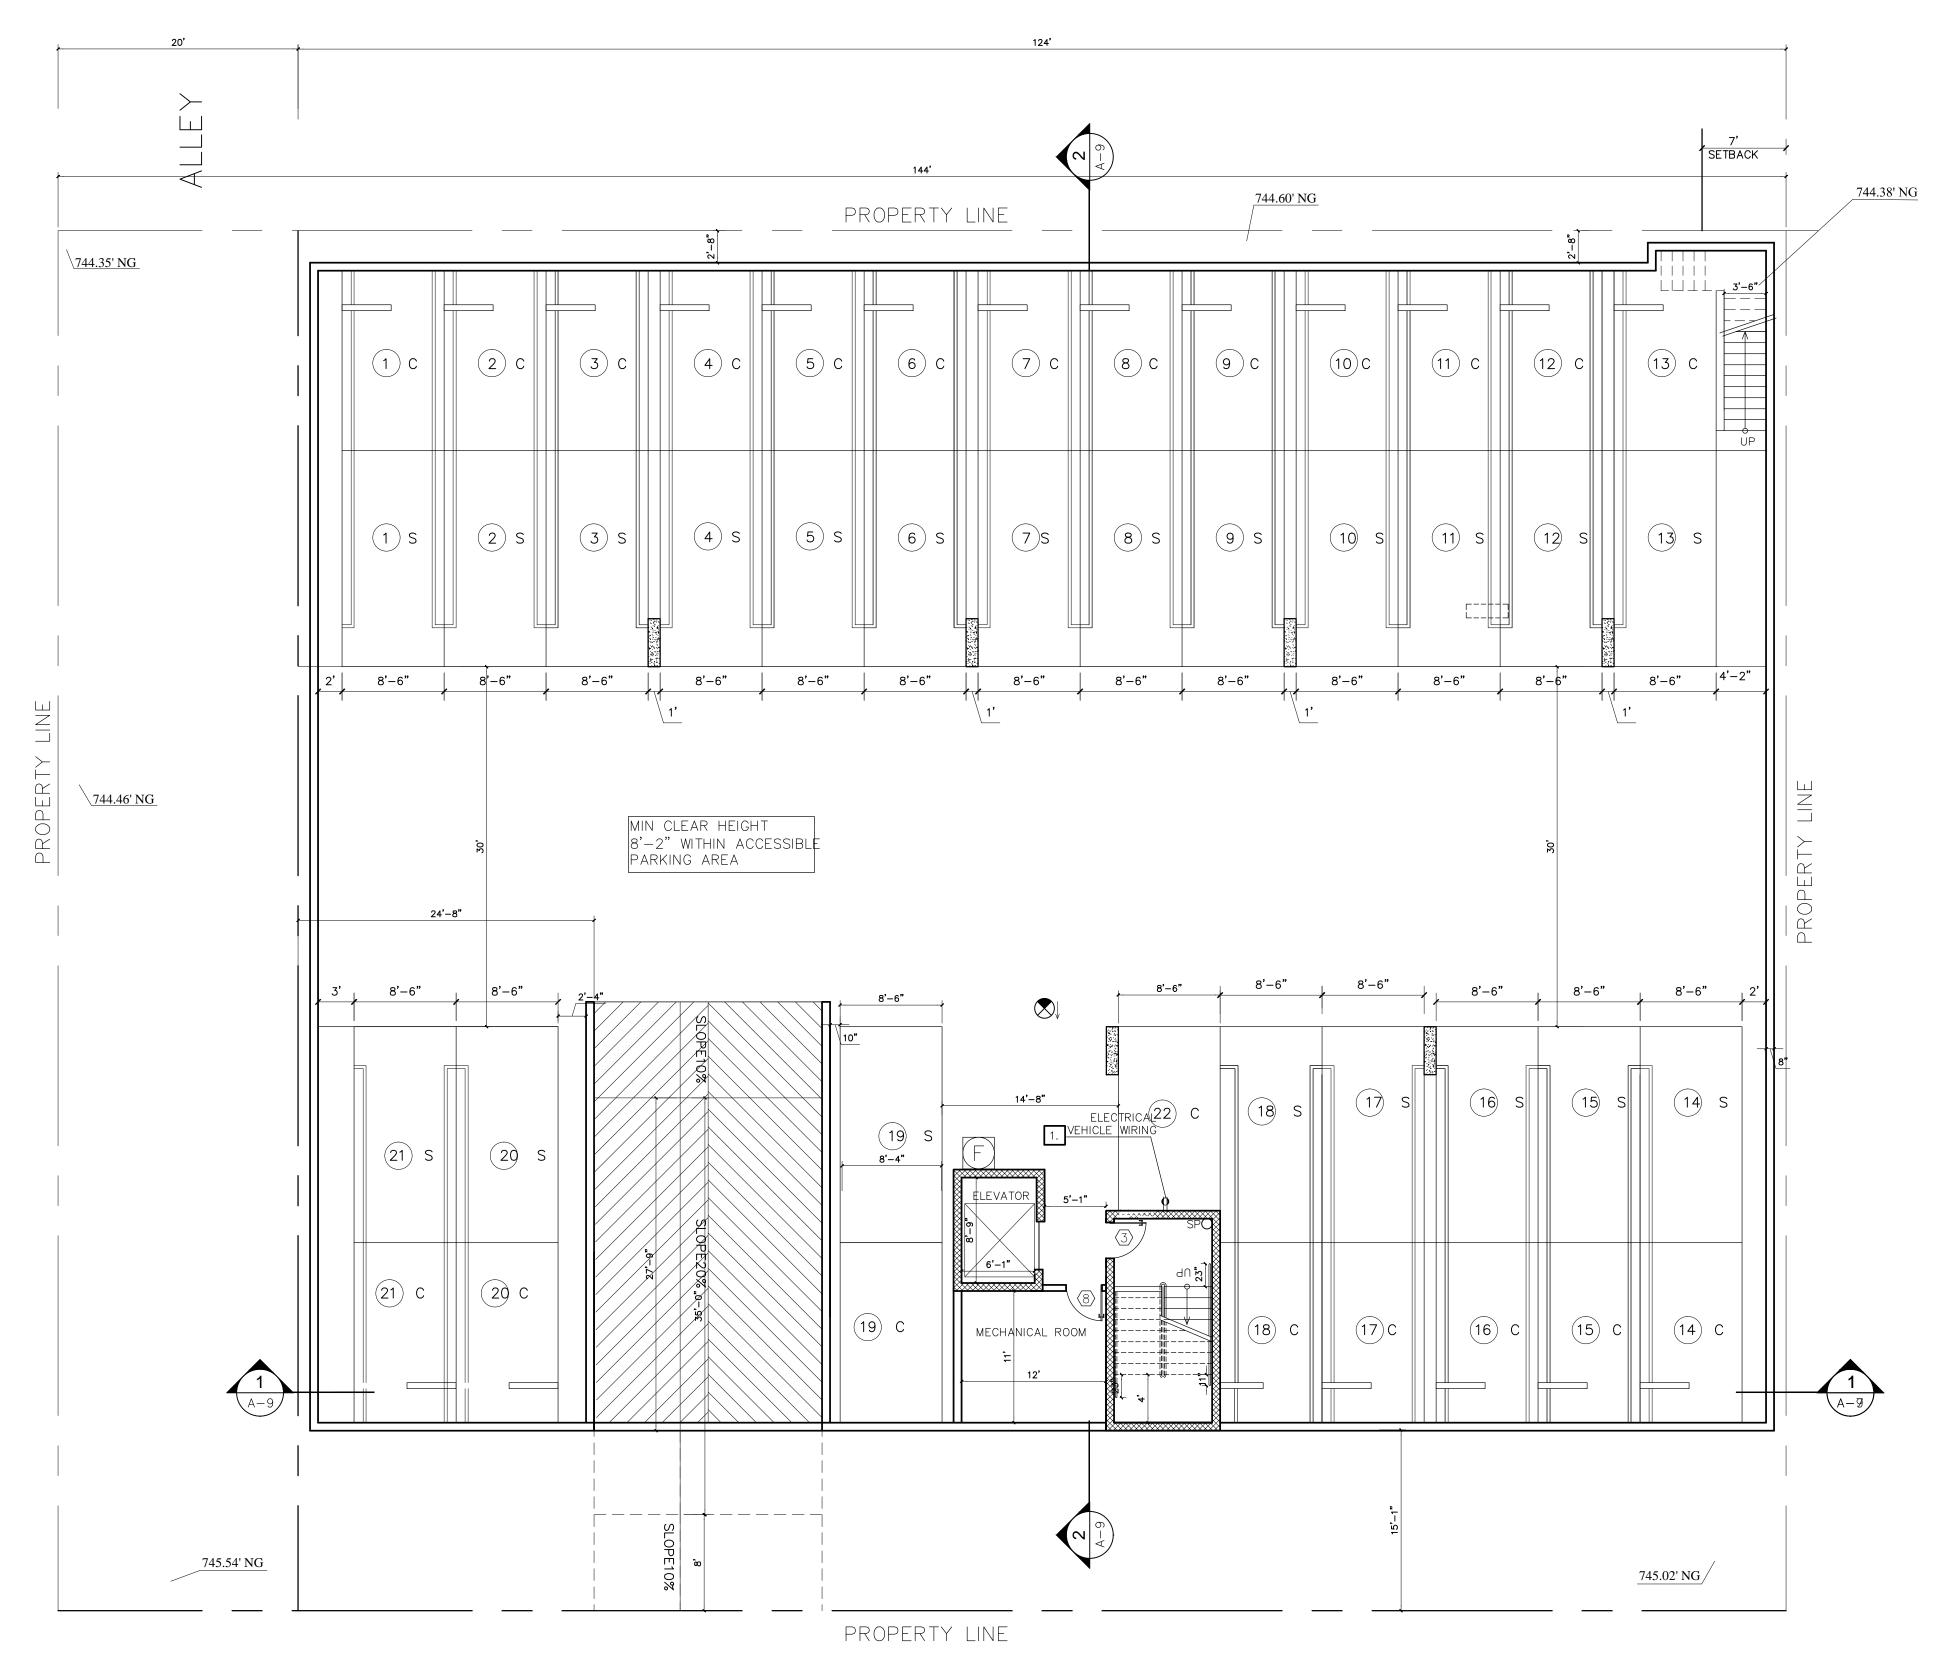

CALVERT STREET


BASEMENT FLOOR PLAN

SCALE: 1/8"=1'-0"



L E G E N DENGINEERING 19562 VENTURA BLVD.SUITE 230 TARZANA, CALIFORNIA 91356 Phone: (818) 758-0018 Cell: (818) 203-3336 fax: (818) 708-2847 2 HOUR RATED STC 50 1 HOUR RATED STC 50 HARD WIRED SMOKE DETECTOR W/ BATTERY BACK-UP CARBON MONOXIDE & HARD WIRED SMOKE DETECTOR W/ BATTERY BACK-UP MECHANICAL VENT, 7 1/2 AIR CHANGE PER HOUR, DIRECTLY TO THE OUTSIDE "ENERGY STAR" W/ REVISION HUMIDISTAT \Rightarrow GROUND- FAULT CIRCUIT-INTERUPTER 4" MIN. METAL DRYER VENT, DIRECTLY TO OUTSIDE MAXIMUM 14' LENGTH W/TWO ELBOWS FROM DRYER 6520 WEST 9 EXIT SIGN WATER CURTAIN MARK GOLESTANI 6 PLAAT AVE # 904 1 HILL CA 91309 WATER HEATER OWNER CLASS "I" STANDPIPE BALCONY W/ CROSSFIELD PRODUCTS CORP DEX-O-TEX COATING (1CBO#2360) OR EQUAL, ICC-ESR-1757 TYPE SQ.FT. LANDSCAPING SQUARE FEET 2A10BC FIRE EXTINGUISHER W/ SEMI- RECESSED CABINET. INSTALL MAX. 48" AFF. TO THE TOP ELECTRICAL VEHICLE SUPPLY WIRING FOR FUTURE, REFER TO SHEET N-1(GB) N O T E S"TEMPORARY PEDESTRIAN PROTECTION SHALL BE PROVIDED AS REQUIRED PER SECTION 3306. OBTAIN PUBLIC WORKS APPROVAL (3201.3,3202.3.4,3306). "DOUBLE STRIPING OF STALLS BE PER ZONING CODE SECTION 12.21A5, CHART No5" 3. ELEVATOR LOBBY DOOR PROVIDED PER SECTION 708.14.1-EXCEPTION 3. SCALE: 1/8"=1'-0" DRAWN: APPROVED: VA. 14-533

SHEETS

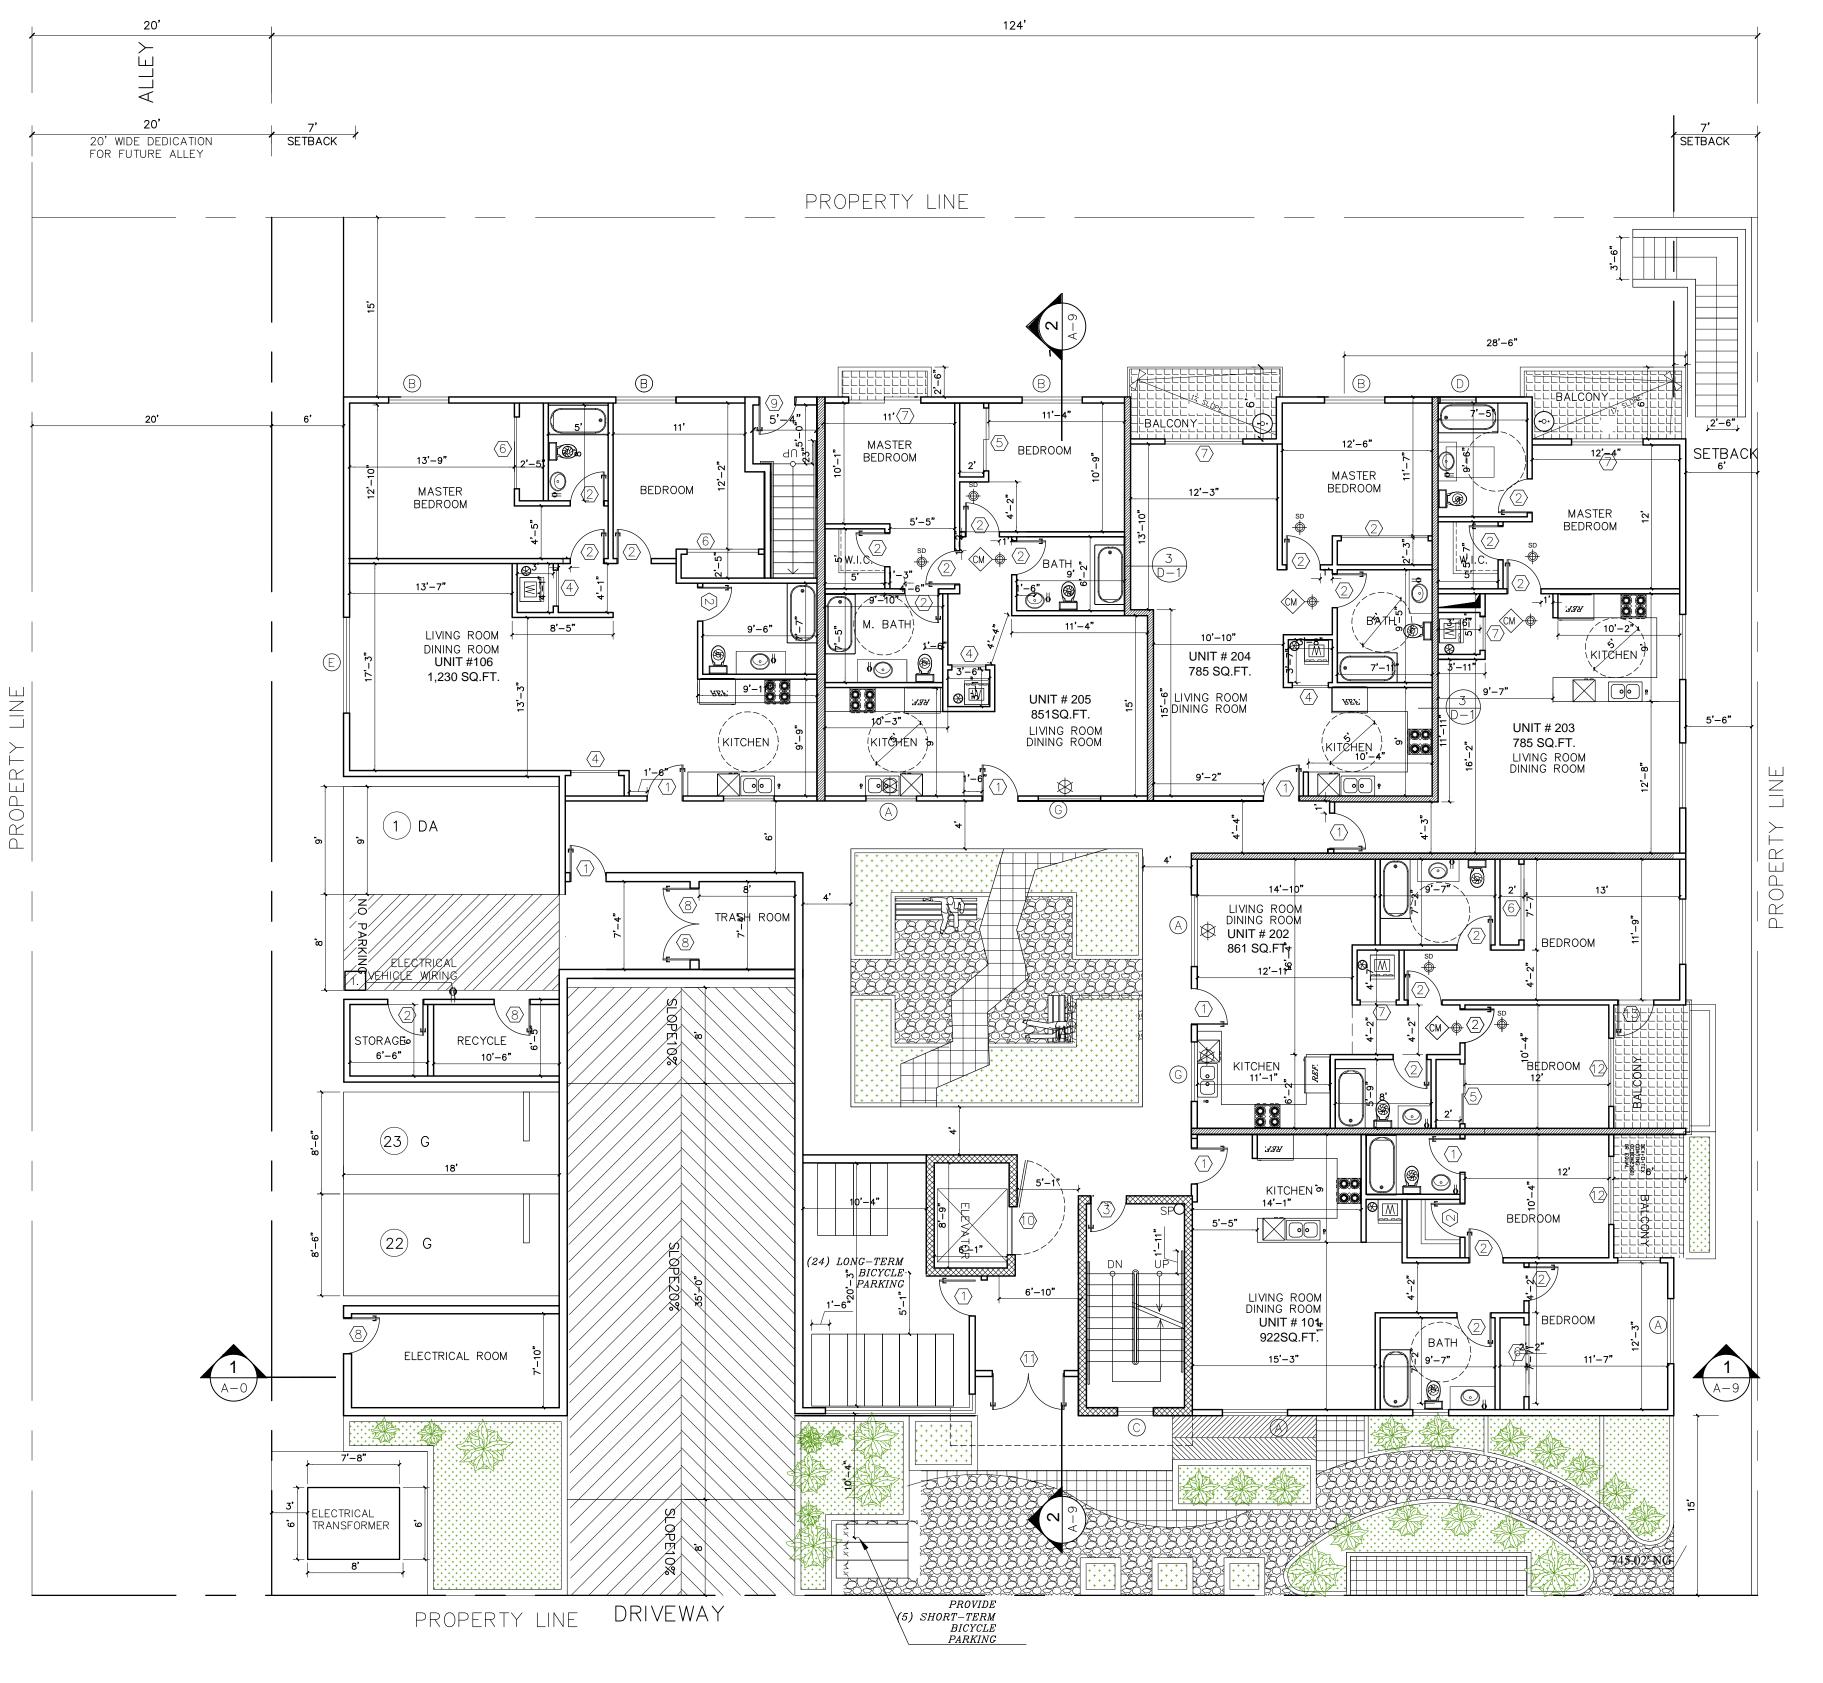

CALVERT STREET

FIRST FLOOR PLAN

SCALE: 1/8"=1'-0"

L E G E N D

×

∑ 2 HOUR RATED STC 50

CD

 \Rightarrow

1 HOUR RATED STC 50

HARD WIRED SMOKE DETECTOR W/ BATTERY BACK-UP

CARBON MONOXIDE & HARD WIRED SMOKE DETECTOR W/ BATTERY BACK-UP

REVISION

6520 WEST 9

MARK GOLESTANI 6 PLAAT AVE # 904 V HILL CA 91309

MECHANICAL VENT, 7 1/2 AIR CHANGE PER HOUR, DIRECTLY TO THE OUTSIDE "ENERGY STAR" W/HUMIDISTAT

GROUND- FAULT CIRCUIT-INTERUPTER

4" MIN. METAL DRYER VENT, DIRECTLY TO OUTSIDE MAXIMUM 14' LENGTH W/TWO ELBOWS FROM DRYER

EXIT SIGN

CLASS "I" STANDPIPE

BALCONY W/ CROSSFIELD PRODUCTS CORP.

DEX-O-TEX COATING (1CBO#2360) OR

EQUAL, ICC-ESR-1757 TYPE

SQ.FT.

LANDSCAPING SQUARE FEET

F

2A10BC FIRE EXTINGUISHER
W/ SEMI- RECESSED CABINET.
INSTALL MAX. 48" AFF. TO THE TOP

1. ELECTRICAL VEHICLE SUPPLY WIRING FOR FUTURE, REFER TO SHEET N-1(GB)

NOTES


FIRE RATED WALLS

- 1. ALL PARTY WALLS SHALL BE 1 HOUR RATED
- 2. WALLS IN SHAFTS AS ELEVATOR, STAIRWAY, ETC SHALL BE 2 HOURS RATED
- 3. CORRIDORS SHALL BE 1 HOUR RATED
- 4. ALL BEARING WALLS SHALL BE 1 HOUR RATED
- 5. THE FLOOR/CEILING ASSEMBLIES SHALL BE 1 HOUR RATED.
- * WATER CURTAIN INSTALLATION SHALL BE AS PER BUILDING & SAFETY MECH. PLAN 18"

 NON-COMBUSTIBLE

 DRAFT STOP SHALL BE PROVIDED.




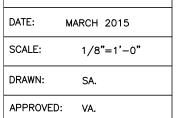

FLOOR

HEET:

A — 3

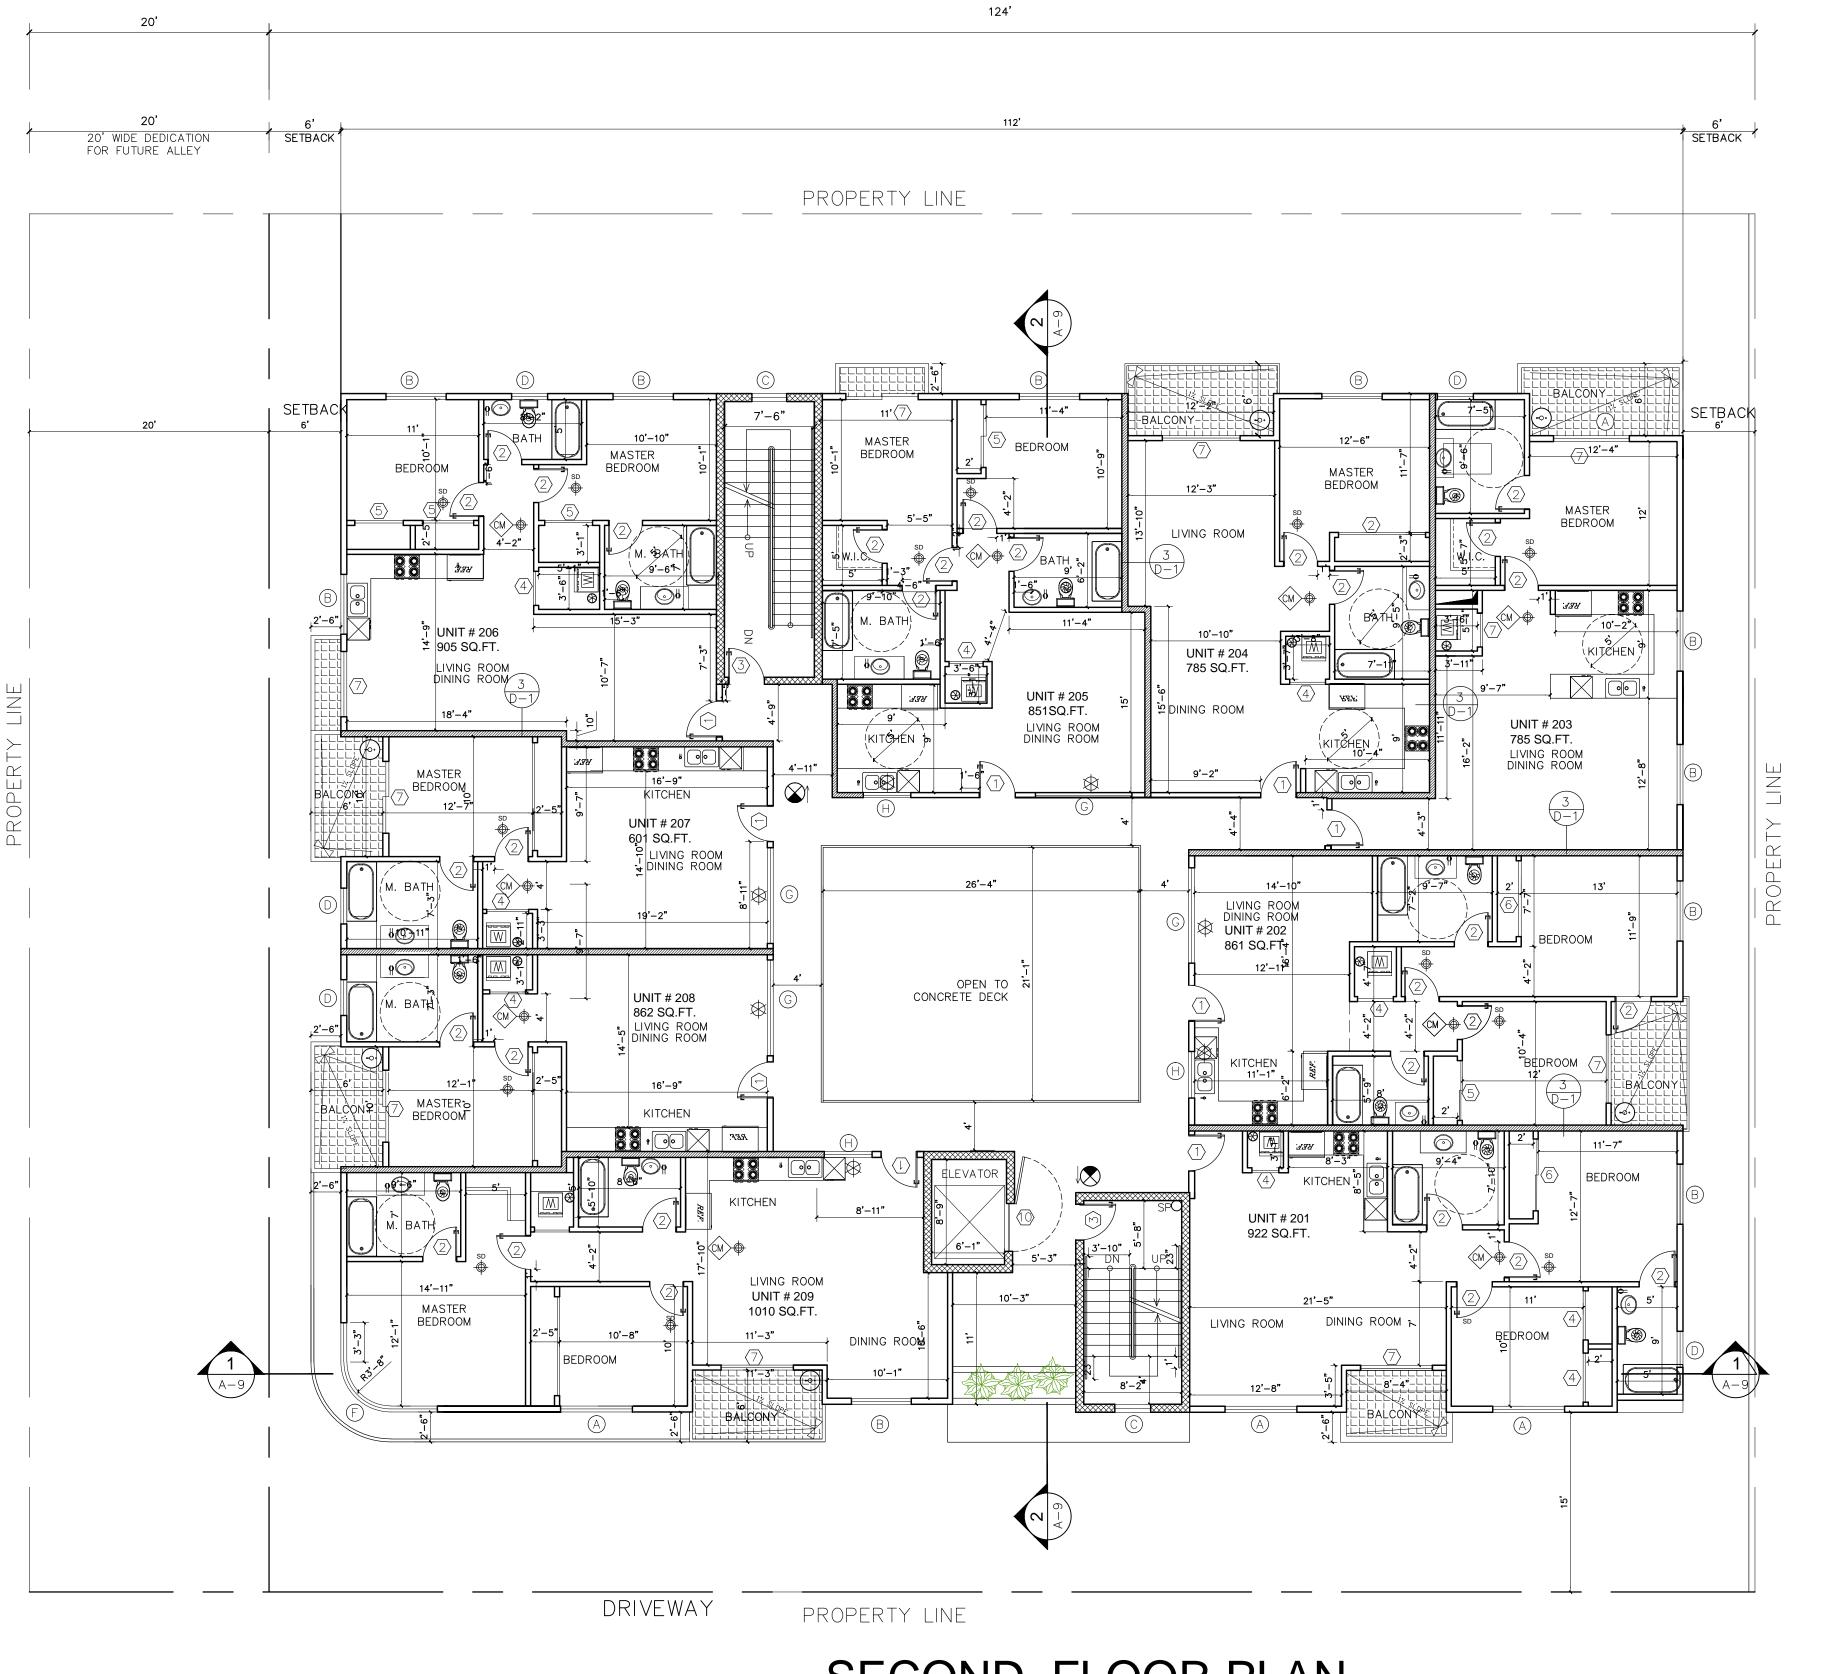

SECOND FLOOR PLAN

SCALE: 1/8"=1'-0"



2 HOUR RATED STC 50

1 HOUR RATED STC 50

HARD WIRED SMOKE DETECTOR W/ BATTERY BACK-UP

CARBON MONOXIDE & HARD WIRED SMOKE DETECTOR W/ BATTERY BACK-UP

MECHANICAL VENT, 7 1/2 AIR CHANGE PER HOUR, DIRECTLY TO THE OUTSIDE "ENERGY STAR" W/ HUMIDISTAT

GROUND- FAULT CIRCUIT-INTERUPTER

REVISION

6520 WEST 9

MARK GOLESTANI 6 PLAAT AVE # 904 V HILL CA 91309

 \Rightarrow

4" MIN. METAL DRYER VENT, DIRECTLY TO OUTSIDE MAXIMUM 14' LENGTH W/TWO ELBOWS FROM DRYER

EXIT SIGN

WATER CURTAIN WATER HEATER

CLASS "I" STANDPIPE

BALCONY W/ CROSSFIELD PRODUCTS CORP. DEX-O-TEX COATING (1CBO#2360) OR EQUAL, ICC-ESR-1757 TYPE

SQ.FT.

LANDSCAPING SQUARE FEET

2A10BC FIRE EXTINGUISHER W/ SEMI- RECESSED CABINET. INSTALL MAX. 48" AFF. TO THE TOP

ELECTRICAL VEHICLE SUPPLY WIRING FOR FUTURE, REFER TO SHEET N-1(GB)


N O T E S


FIRE RATED WALLS

- 1. ALL PARTY WALLS SHALL BE 1 HOUR RATED
- 2. WALLS IN SHAFTS AS ELEVATOR, STAIRWAY, ETC SHALL BE 2 HOURS RATED
- 3. CORRIDORS SHALL BE 1 HOUR RATED
- 4. ALL BEARING WALLS SHALL BE 1 HOUR RATED
- 5. THE FLOOR/CEILING ASSEMBLIES SHALL BE 1 HOUR RATED.
- * WATER CURTAIN INSTALLATION SHALL BE AS PER BUILDING & SAFETY MECH. PLAN 18" NON-COMBUSTIBLE DRAFT STOP SHALL BE PROVIDED.



DATE:	MARCH 2015
SCALE:	1/8"=1'-0"
DRAWN:	SA.
APPROVED:	VA.

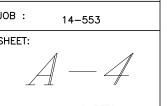

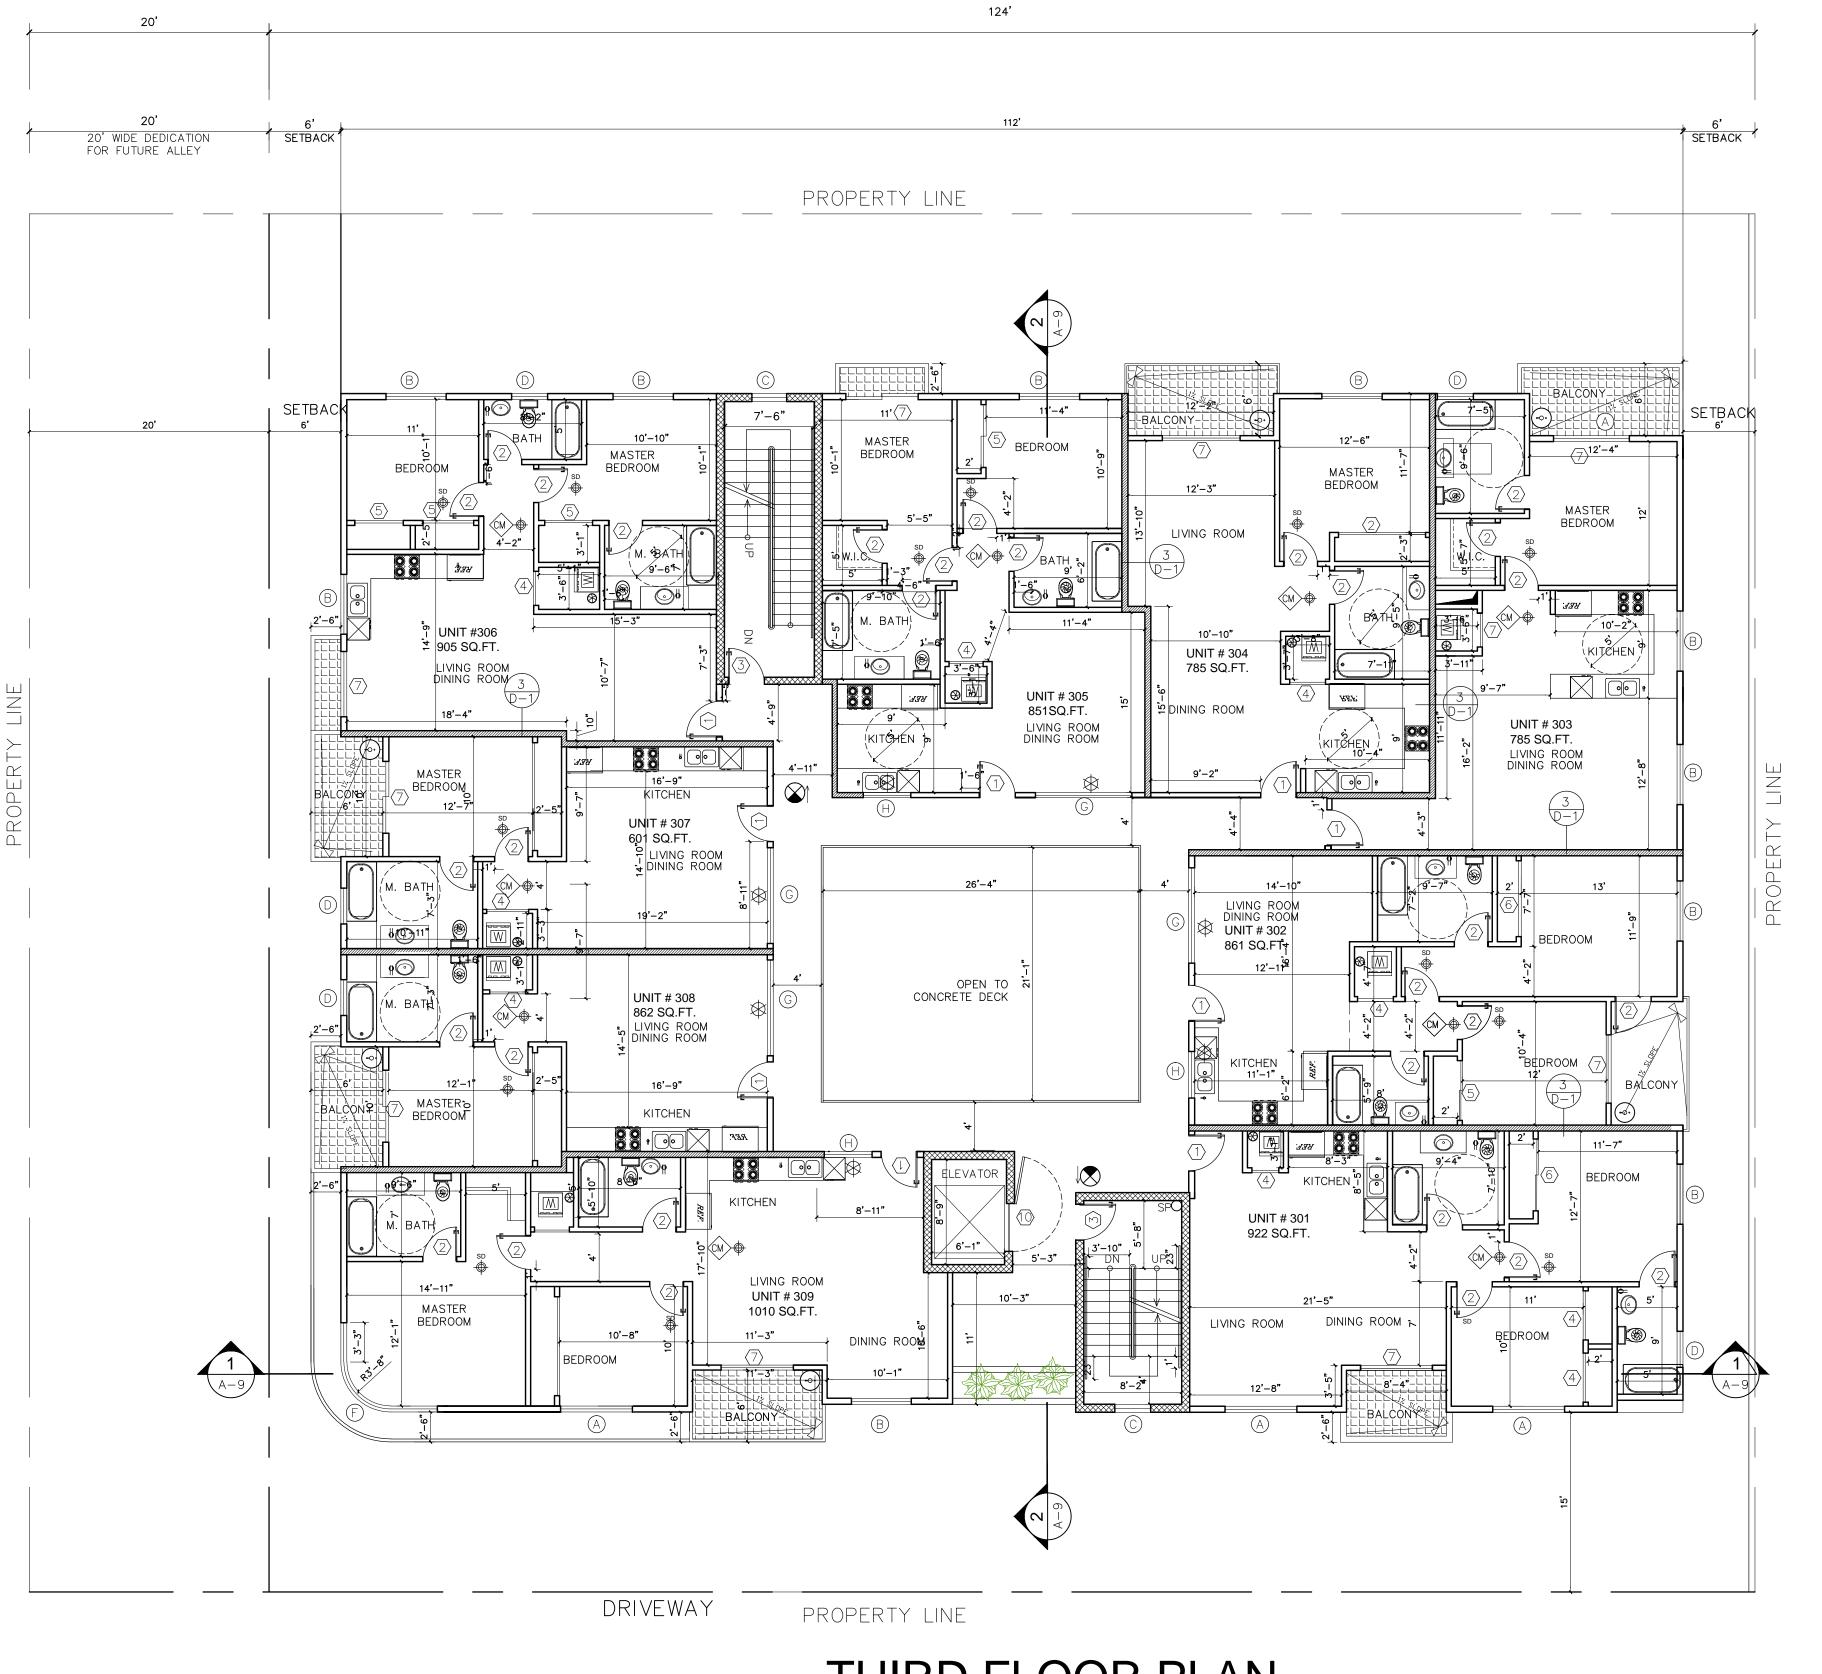

THIRD FLOOR PLAN

SCALE: 1/8"=1'-0"



2 HOUR RATED STC 50

1 HOUR RATED STC 50

HARD WIRED SMOKE DETECTOR W/ BATTERY BACK-UP

CARBON MONOXIDE & HARD WIRED SMOKE DETECTOR W/ BATTERY BACK-UP

MECHANICAL VENT, 7 1/2 AIR CHANGE PER HOUR, DIRECTLY TO THE OUTSIDE "ENERGY STAR" W/ HUMIDISTAT

GROUND- FAULT CIRCUIT-INTERUPTER

 \Rightarrow

4" MIN. METAL DRYER VENT, DIRECTLY TO OUTSIDE MAXIMUM 14' LENGTH W/TWO ELBOWS FROM DRYER

EXIT SIGN

WATER CURTAIN

WATER HEATER CLASS "I" STANDPIPE

> BALCONY W/ CROSSFIELD PRODUCTS CORP. DEX-O-TEX COATING (1CBO#2360) OR EQUAL, ICC-ESR-1757 TYPE

SQ.FT.

LANDSCAPING SQUARE FEET

2A10BC FIRE EXTINGUISHER W/ SEMI- RECESSED CABINET. INSTALL MAX. 48" AFF. TO THE TOP

ELECTRICAL VEHICLE SUPPLY WIRING FOR FUTURE, REFER TO SHEET N-1(GB)

NOTES

FIRE RATED WALLS

- 1. ALL PARTY WALLS SHALL BE 1 HOUR RATED
- 2. WALLS IN SHAFTS AS ELEVATOR, STAIRWAY, ETC SHALL BE 2 HOURS RATED
- 3. CORRIDORS SHALL BE 1 HOUR RATED
- 4. ALL BEARING WALLS SHALL BE 1 HOUR RATED
- 5. THE FLOOR/CEILING ASSEMBLIES SHALL BE 1 HOUR RATED.
- * WATER CURTAIN INSTALLATION SHALL BE AS PER BUILDING & SAFETY MECH. PLAN 18" NON-COMBUSTIBLE DRAFT STOP SHALL BE PROVIDED.




SCALE: 1/8"=1'-0" DRAWN:

REVISION

6520 WEST 9

MARK GOLESTANI 6 PLAAT AVE # 904 V HILL CA 91309

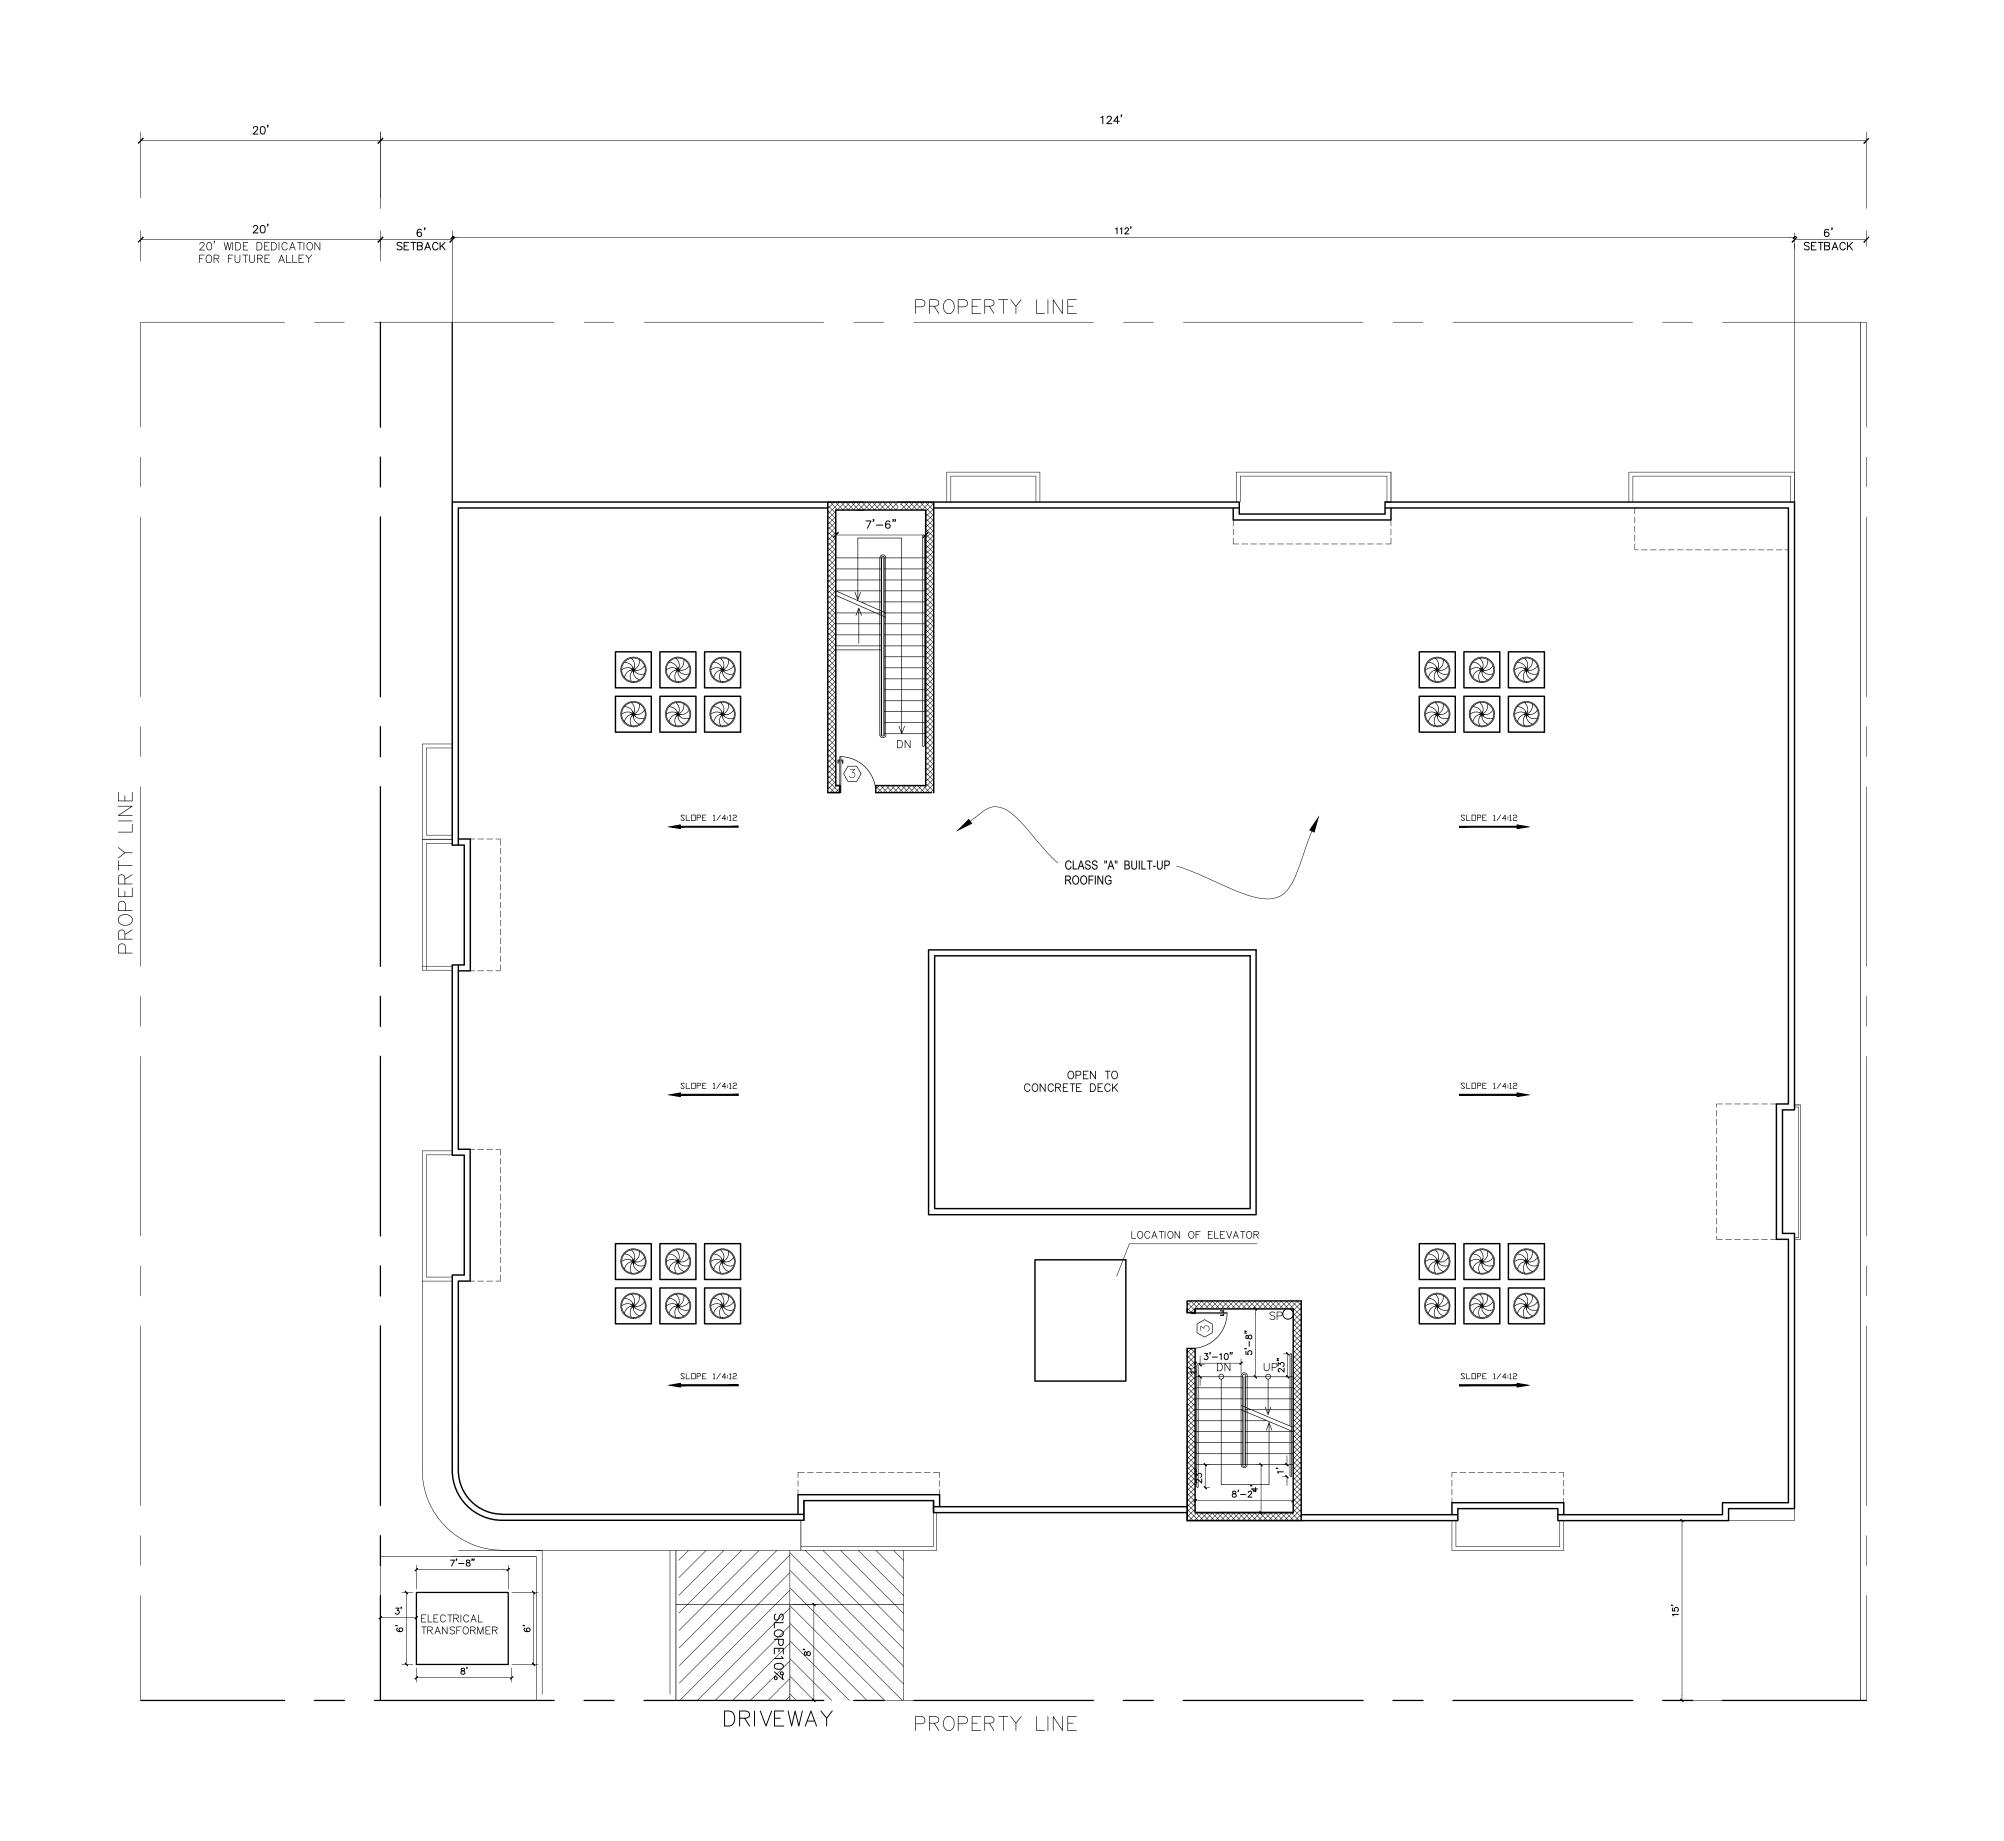



2 HOUR RATED STC 50

1 HOUR RATED STC 50

HARD WIRED SMOKE DETECTOR W/ BATTERY BACK-UP

⟨CM⟩

CARBON MONOXIDE & HARD WIRED SMOKE DETECTOR W/ BATTERY BACK-UP

MECHANICAL VENT, 7 1/2 AIR CHANGE PER HOUR, DIRECTLY TO THE OUTSIDE "ENERGY STAR" W/ HUMIDISTAT

GROUND- FAULT CIRCUIT-INTERUPTER

REVISION

6520 WEST 9

MARK GOLESTANI 6 PLAAT AVE # 904 V HILL CA 91309

4" MIN. METAL DRYER VENT, DIRECTLY TO OUTSIDE MAXIMUM 14' LENGTH W/TWO ELBOWS FROM DRYER

 \Rightarrow

EXIT SIGN

WATER CURTAIN WATER HEATER

CLASS "I" STANDPIPE SP O

> BALCONY W/ CROSSFIELD PRODUCTS CORP. DEX-O-TEX COATING (1CBO#2360) OR EQUAL, ICC-ESR-1757 TYPE

SQ.FT. LANDSCAPING SQUARE FEET

2A10BC FIRE EXTINGUISHER W/ SEMI- RECESSED CABINET. INSTALL MAX. 48" AFF. TO THE TOP

ELECTRICAL VEHICLE SUPPLY WIRING FOR FUTURE, REFER TO SHEET N-1(GB)

N O T E S

FIRE RATED WALLS

- 1. ALL PARTY WALLS SHALL BE 1 HOUR RATED
- 2. WALLS IN SHAFTS AS ELEVATOR, STAIRWAY, ETC SHALL BE 2 HOURS RATED
- 3. CORRIDORS SHALL BE 1 HOUR RATED
- 4. ALL BEARING WALLS SHALL BE 1 HOUR RATED
- 5. THE FLOOR/CEILING ASSEMBLIES SHALL BE 1 HOUR RATED.
- * WATER CURTAIN INSTALLATION SHALL BE AS PER BUILDING & SAFETY MECH. PLAN 18" NON-COMBUSTIBLE DRAFT STOP SHALL BE PROVIDED.



SCALE: 1/8"=1'-0" DRAWN:

ROOF





WEST ELEVATION

SCALE: 1/8"=1'-0"

DATE: MARCH 2015

SCALE: 1/8"=1'-0"

DRAWN:

APPROVED: VA.

JOB: 14-533

SHEETS

